December 11, 2023

City of Auburn Planning Staff 60 Court Street Auburn, ME 04210

## Re: Auburn Solar, LLC Special Exception Permit Revision and Extension

## Dear Planning Staff,

I hope this letter finds you well. Auburn Solar, LLC, wholly owned by Hexagon Energy, LLC, was granted a Special Exception Permit by the City of Auburn Planning Board on March 9, 2021. At that time, the project was proposed with a nameplate capacity of 4.00MW (alternating current), to be set upon a fixed-tilt racking system, then downsized to a nameplate capacity of 1.99MW, to be set on a single-axis tracking system, on February 2, 2022.

Based on factors related to CMP's electrical grid and a second round of legislative changes to the state's solar program, we request the planning staff's approval to 1) downsize to 0.99MW (alternating current) and 2) extend the revised permit through July 2026 to meet our expected commercial operation date. This reduction in the project's nameplate power capacity generating will correspond to a decrease in the

Auburn Solar: Minor Site Revision Summary	Original	First Revision	Second Revision
Nameplate Capacity (MWac)	4.000	1.990	0.990
Racking System Type	Fixed Tilt	Single-Axis Tracker	Single-Axis Tracker
Fenced Project Area (Approx. acreage)	16	12.5	7
Wetland Impacts, Sq.Ft: <b>Direct</b> Impacts (PEM "WET MEADOW") -Driven Posts, Fencing Posts	159	50	0
Wetland Impacts, Sq Ft: Indirect Impacts (PEM "WET MEADOW") -Shading, Mowing of Existing Field	84,500	22,215	0
Total Alteration to be Permitted, Sq. Ft., (Direct/Indirect)	84,659	22,265	0

HEXAGON

ENERGY

overall project footprint, now consisting of approximately 7 acres, compared to the first revision's footprint of about 12 acres. This size reduction will allow the project to avoid impacting any wetlands entirely. The table included summarizes the modifications to Auburn Solar's site plan. The permit





extension request is our conservative expectation for when the project will be fully operational and accounts for anticipated contingencies such as weather and construction delays.

I have attached the revised site plans showing the new project layout. As you will see, very little has substantially changed except that the project footprint is now smaller. Despite the change in the racking system, the panels will still maintain a low profile with a maximum height of 8ft above the average ground level of the site.

Please let me know if you have any questions or concerns about this revision. It is my understanding that Planning Staff are able to approve this change without requiring significant changes to the project application and without needing additional Planning Board hearings. If this is the case, please confirm in writing that these site changes are acceptable and approved, or let me know what else would be required.


I look forward to continuing to work with you on this project.

Sincerely,

Cady Merrick

Cady Merrick Manager, Auburn Solar Project Developer, Hexagon Energy



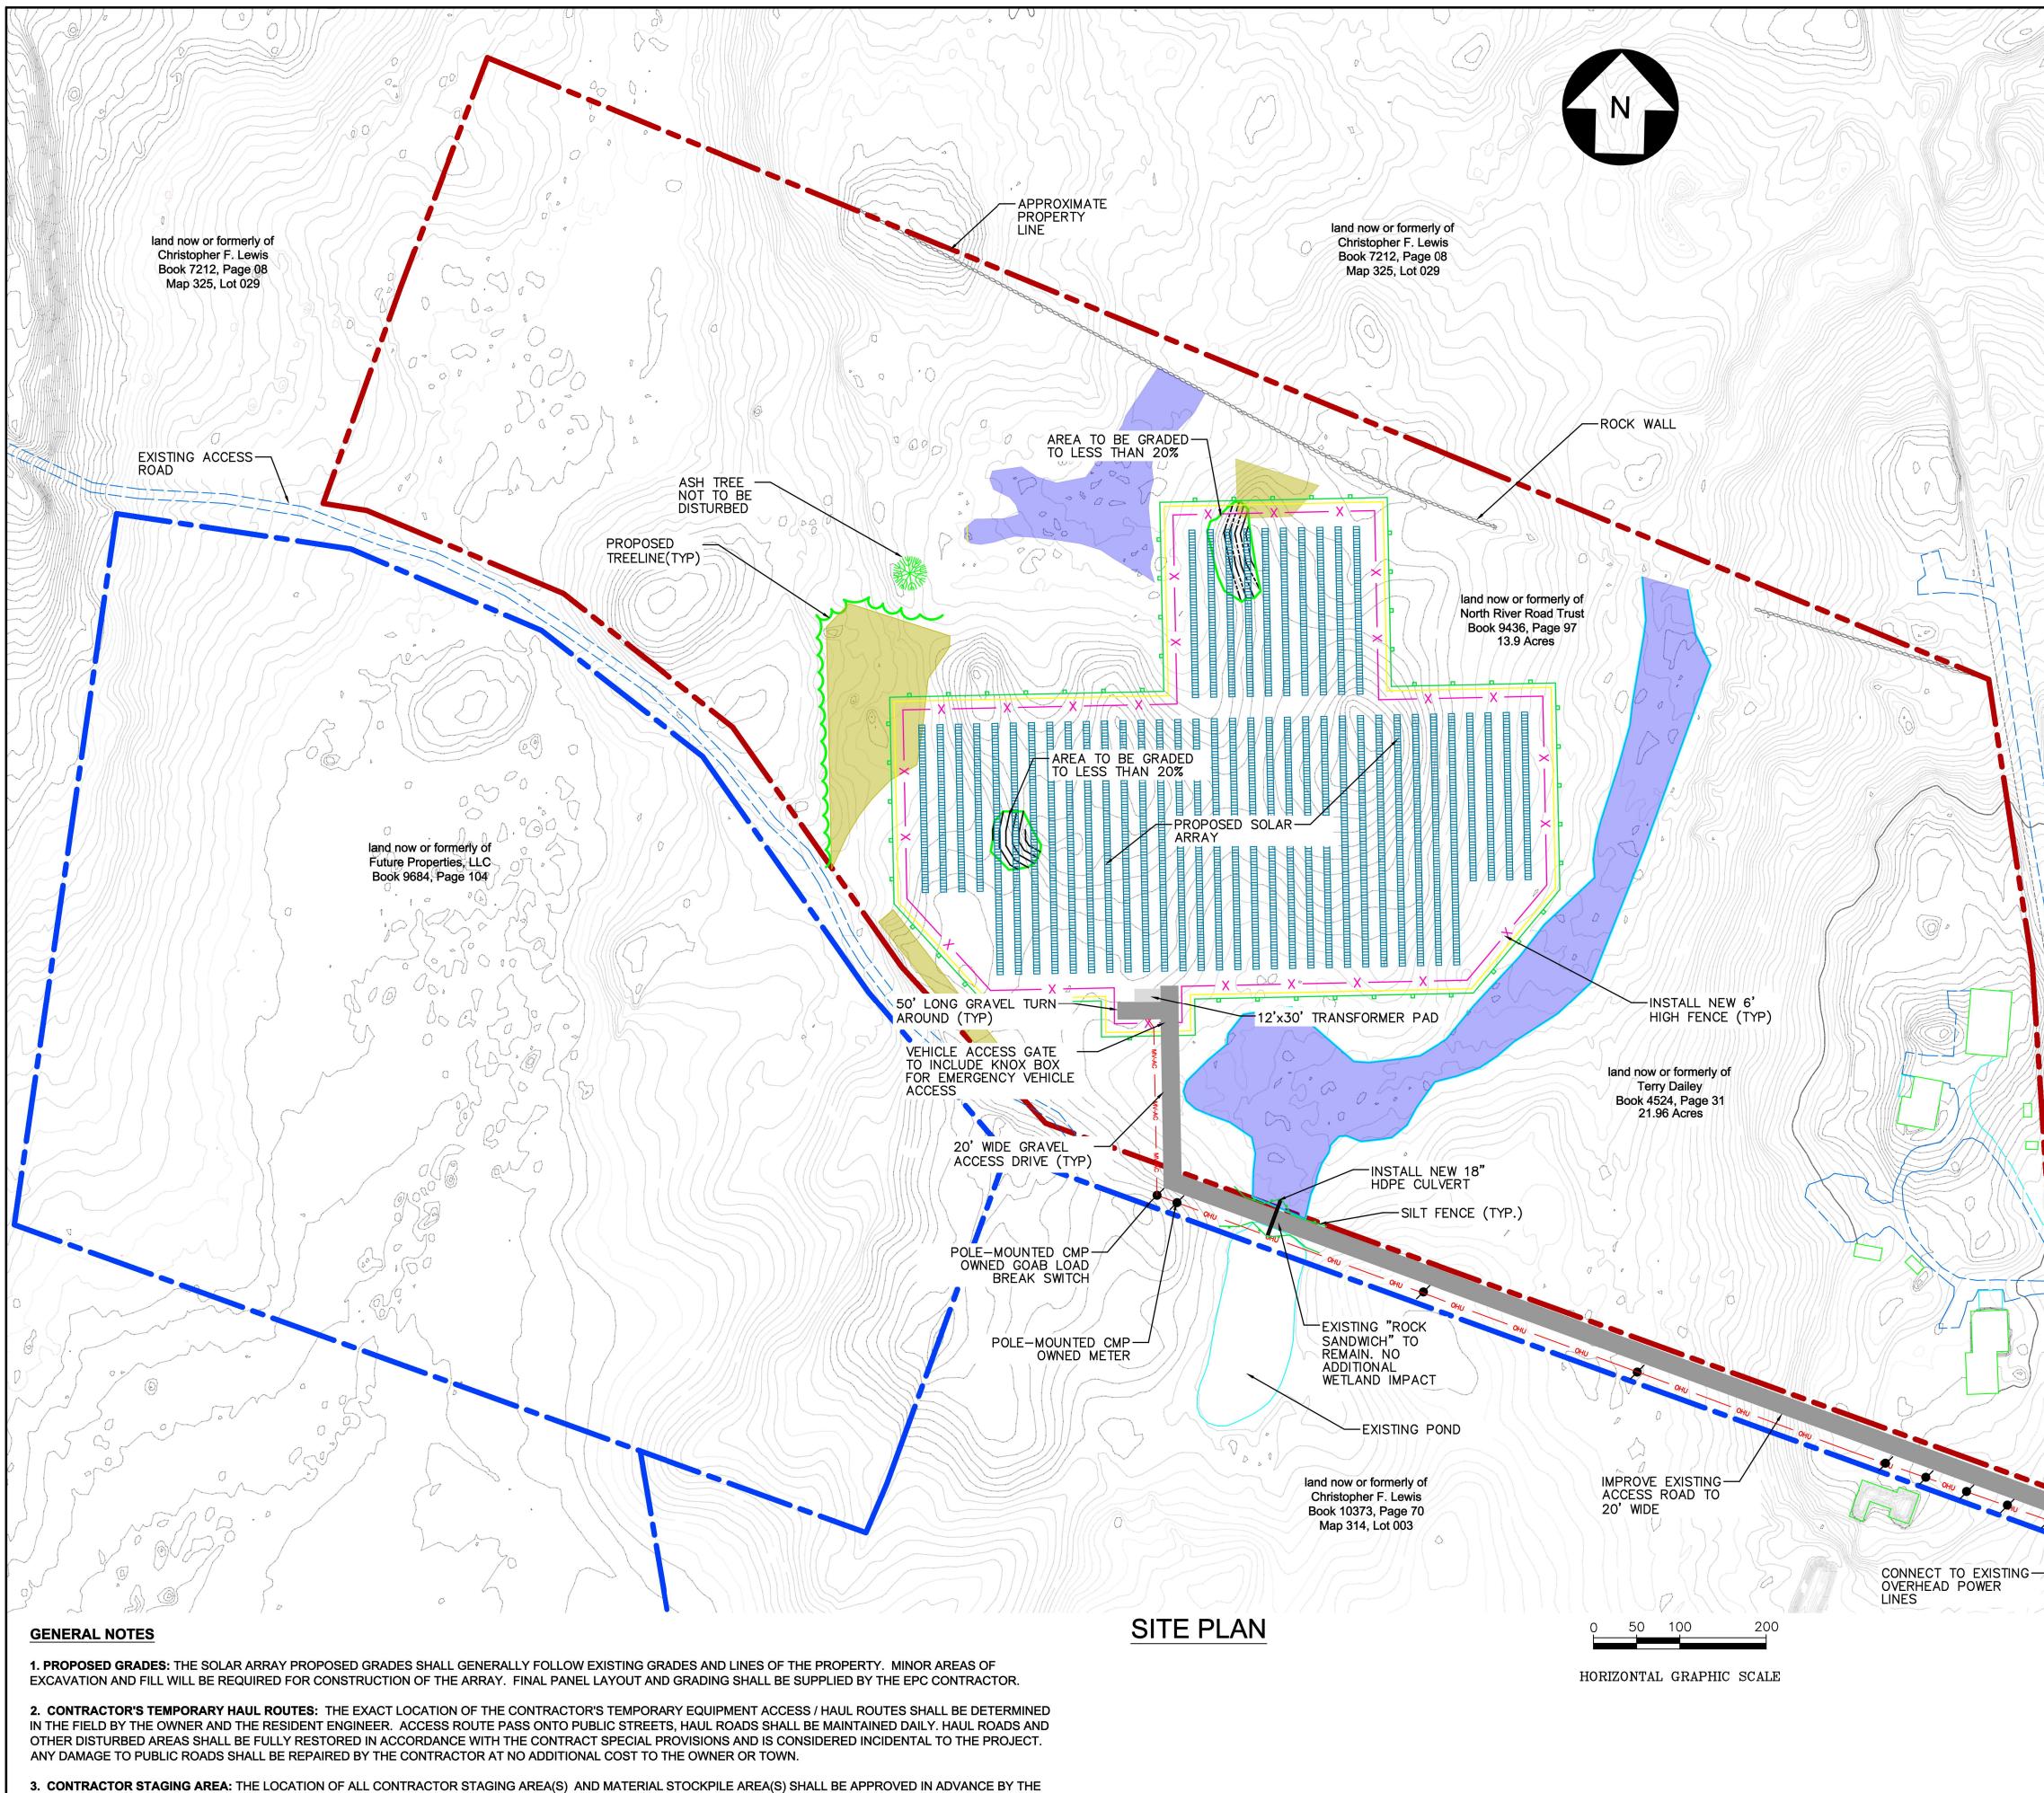


ENGINEER. STAGING AREAS SHALL BE RESTORED TO THEIR ORIGINAL CONDITIONS AND RESTORATION SHALL BE CONSIDERED INCIDENTAL TO THE PROJECT. 4. DEBRIS AND DUST CONTROL: THE CONTRACTOR SHALL STRICTLY CONTROL DEBRIS AND LITTER AT THE WORKSITE. MUD, STONES OR OTHER DEBRIS RESULTING

FROM CONSTRUCTION OPERATIONS SHALL BE PROMPTLY AND COMPLETELY REMOVED FROM PAVEMENTS AS NEEDED. DEBRIS AND DUST CONTROL SHALL BE CONSIDERED INCIDENTAL TO THE PROJECT

5. BURIED UTILITIES: THE CONTRACTOR SHALL BE RESPONSIBLE FOR DETERMINING THE EXACT LOCATION OF ALL BURIED UTILITIES PRIOR TO ANY EXCAVATION. ANY DAMAGE TO SUCH UTILITIES BY THE CONTRACTOR SHALL BE REPAIRED/REPLACED IMMEDIATELY BY THE CONTRACTOR TO THE SATISFACTION OF THE ENGINEER AT NO ADDITIONAL COST TO THE OWNER.

6. WETLANDS: THERE WILL BE NO WETLAND ALTERATION (DIRECT OR INDIRECT) AS A RESULT OF THIS PROJECT

## LEGEND

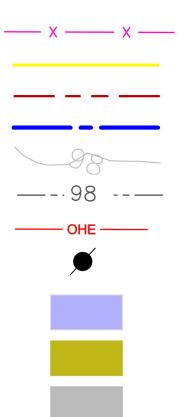


PROPOSED FENCE LIMITS OF DISTURBANCE PROPERTY LINE ABUTTER PROPERTY LINE **EXISTING CONTOUR** PROPOSED CONTOUR OVERHEAD ELECTRICAL PROPOSED UTILITY POLE


DELINEATED WETLAND

AREA TO BE CLEARED


PROPOSED GRAVEL ACCESS ROAD

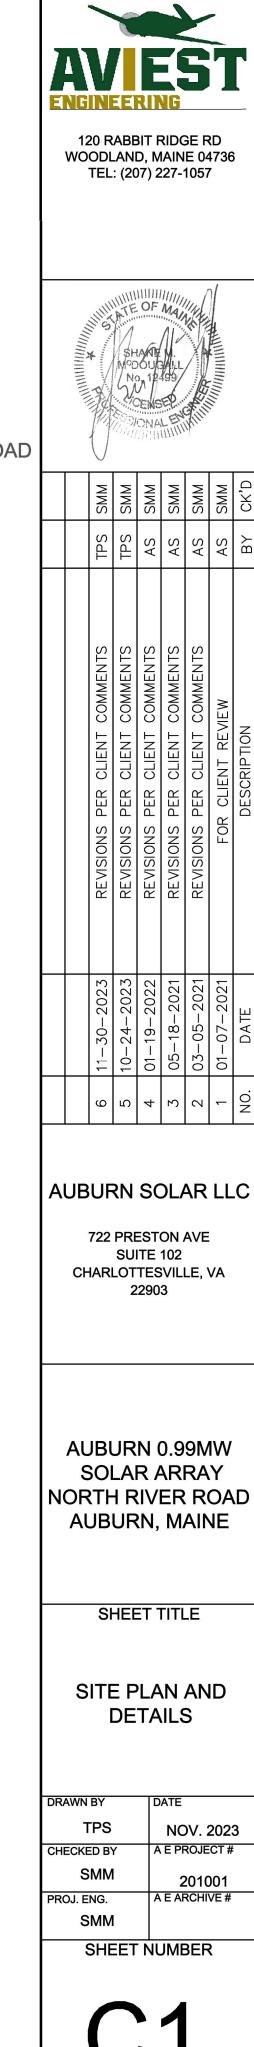

SHEET 1 OF 2

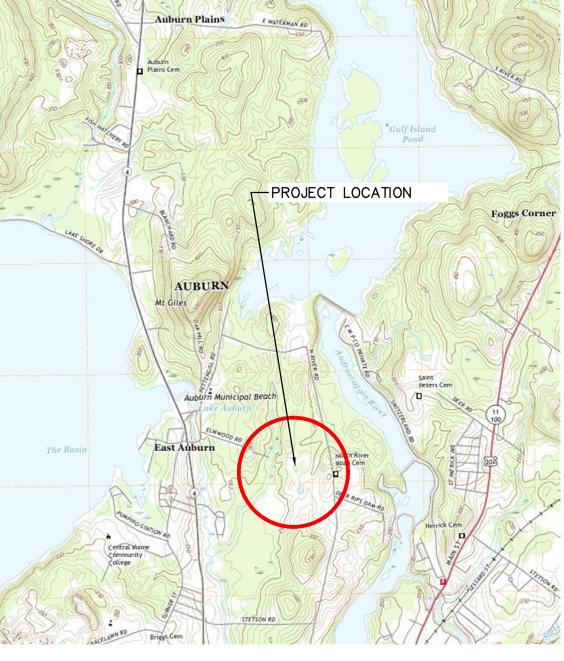

LOCUS MAP

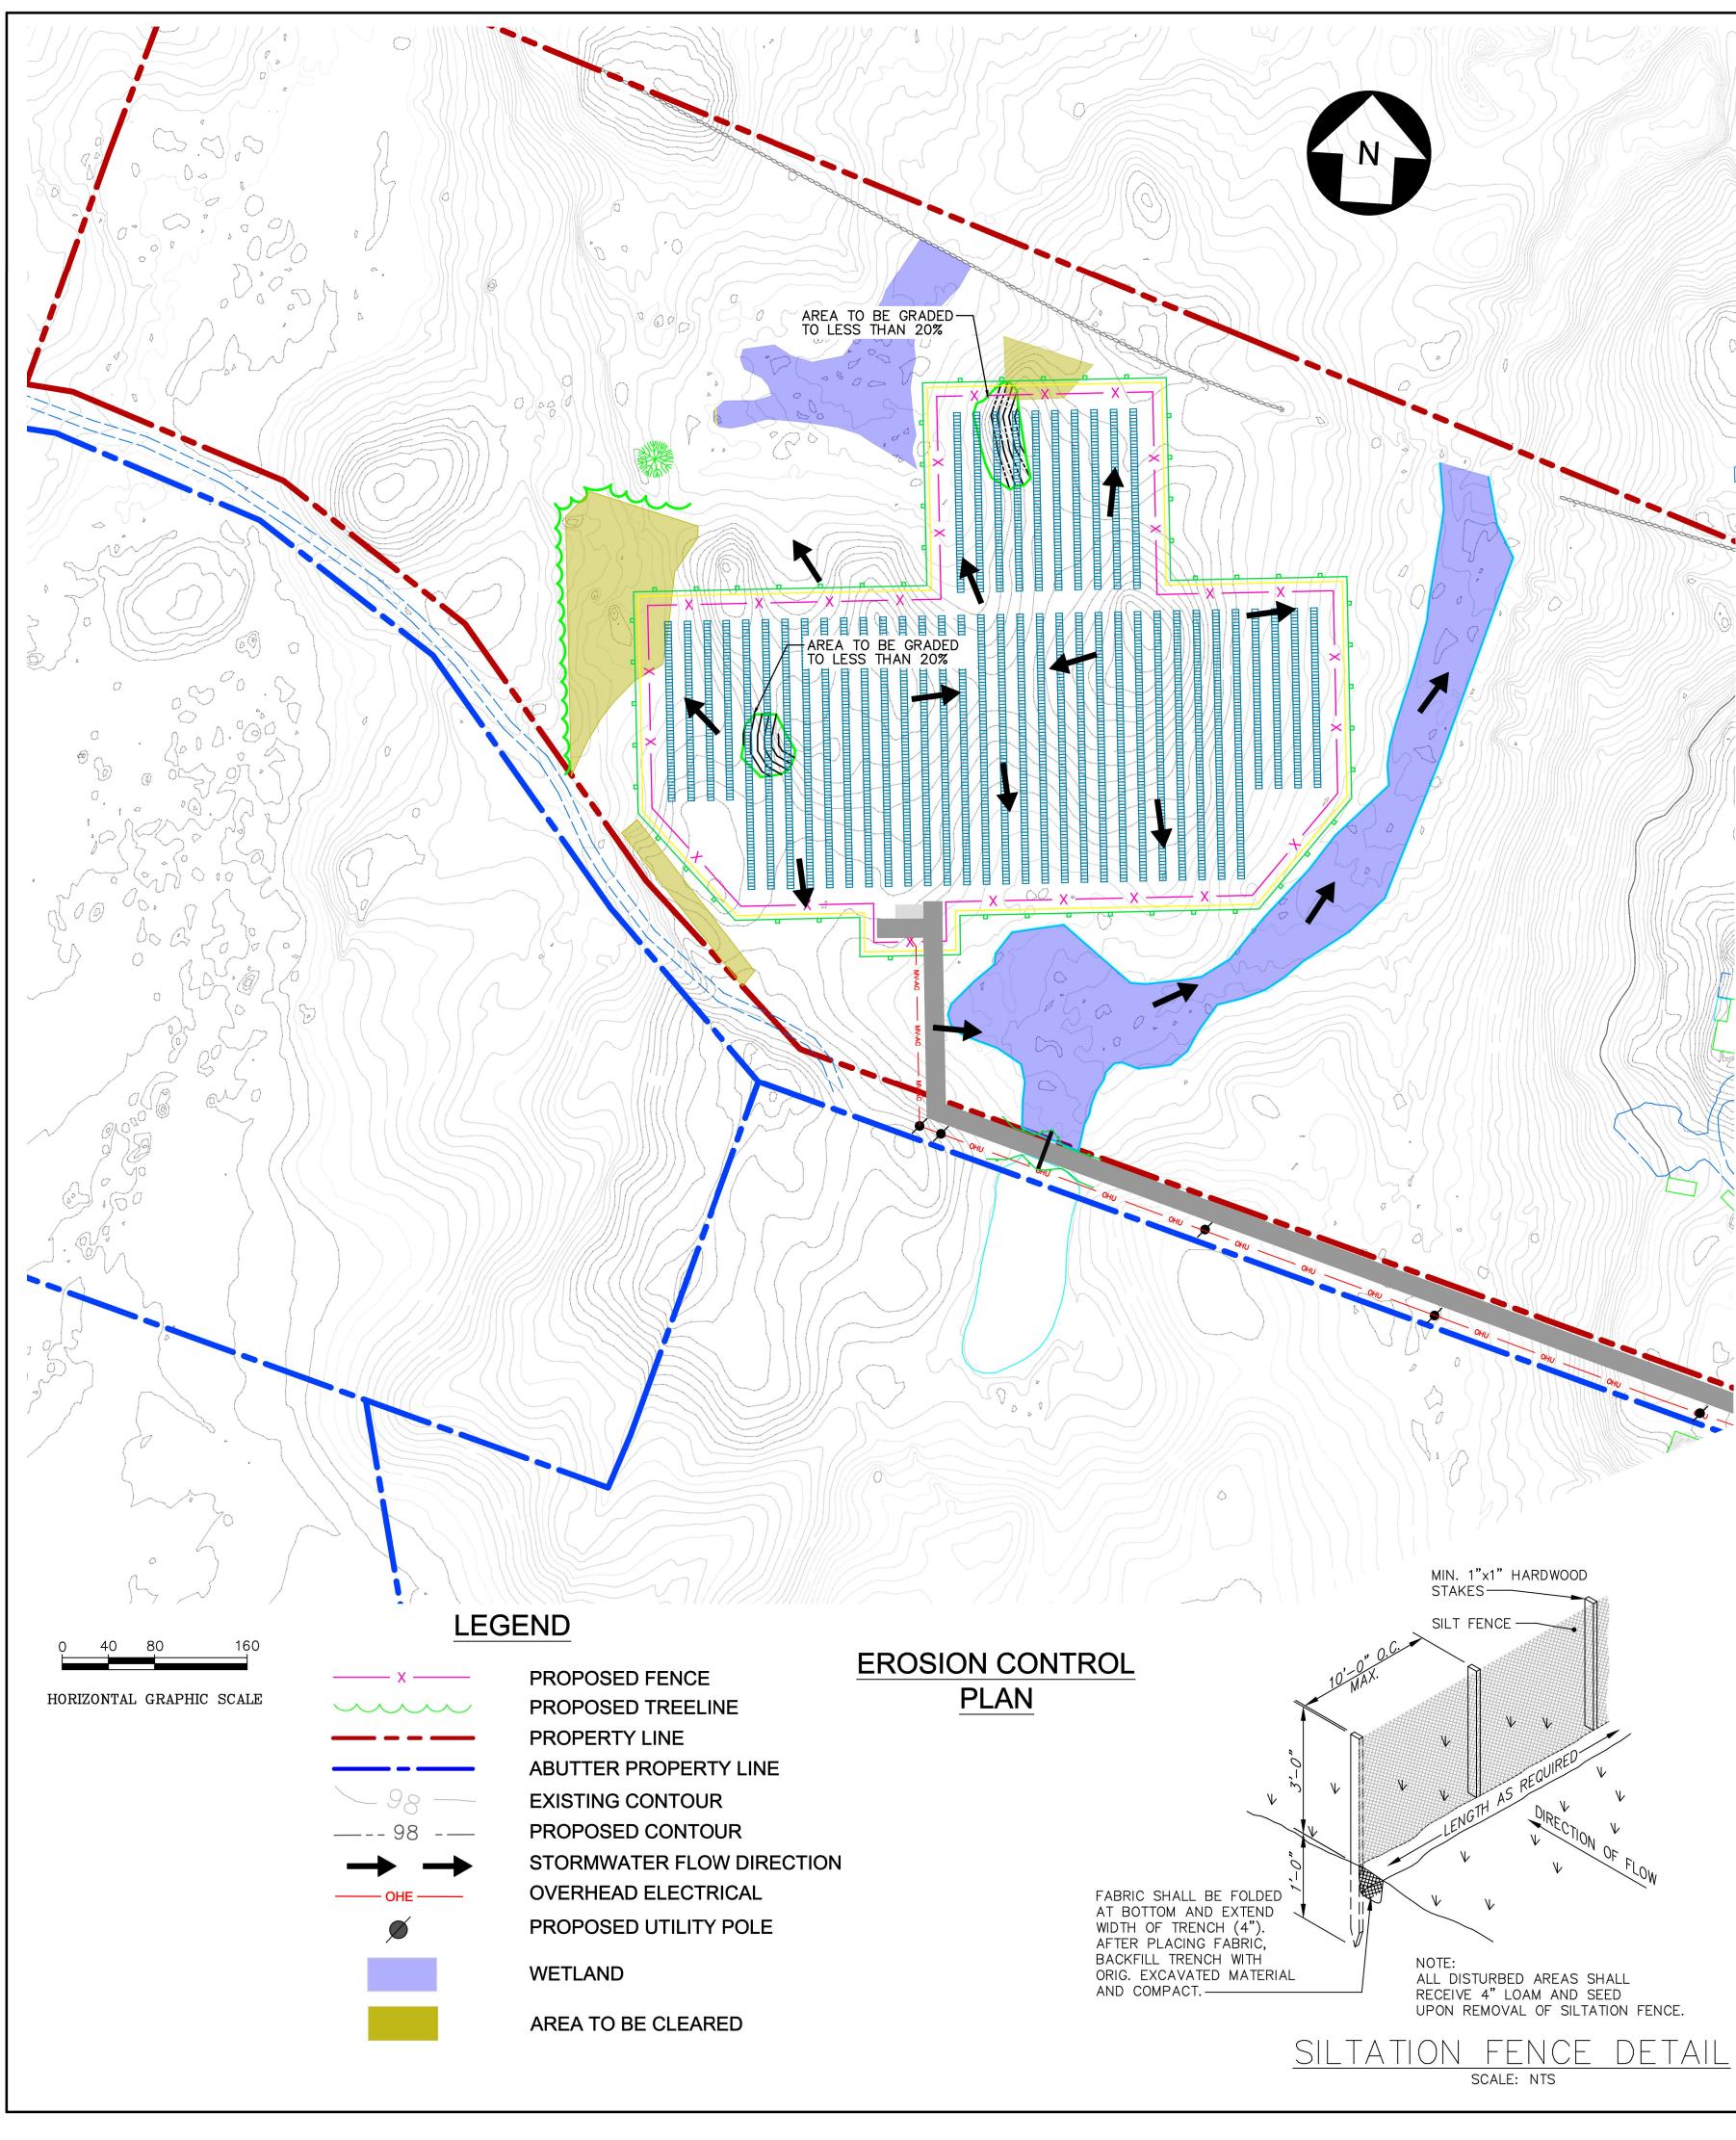

server\Share\2020 Projects\201001-Auburn Solar\Drawings\201001\_ Auburn Solar - 0.99MW REV.dwg 11/30/2023 3:22 F

GENERAL NOTES

EROSION AND SEDIMENTATION CONTROL PLAN

THIS PLAN HAS BEEN DEVELOPED TO PROVIDE A STRATEGY FOR C THIS PLAN IS BASED ON STANDARDS AND SPECIFICATIONS FOR ER AND SEDIMENT CONTROL BMP MANUAL FOR THE MAINE DEPARTMEN

GENERAL CONSTRUCTION DETAILS

THE EQUIPMENT ANTICIPATED TO BE USED FOR CONSTRUCTION MAY ON-SITE EROSION CONTROL METHODS WILL BE UTILIZED. THE FOL LANDS:

1. PERMANENT SOIL EROSION CONTROL MEASURES FOR ALL SLOPES AFTER FINAL GRADING HAS BEEN COMPLETED. WHEN IT IS NOT PO WILL BE IMPLEMENTED WITHIN SEVEN (7) CALENDAR DAYS OF EXPO WOOD FIBER MULCH AT A RATE OF 75–90 LBS PER 1000 SF BY AREAS (INCLUDING LAKES AND STREAMS), APPLY MULCH WITHIN 48

2. PRIOR TO GRUBBING OR ANY EARTHMOVING OPERATION, SILT FEM PROTECTION AGAINST CONSTRUCTION RELATED EROSION. SILT FEND

3. TEMPORARY SILT CONTROL RISERS SHALL BE INSTALLED AT ALL

4. ALL SILT FENCE/ TEMPORARY SEDIMENT CONTROL MEASURES WI MORE) OR SNOW MELT, OR DAILY DURING PROLONGED RAINFALL. REMOVED BEFORE IT HAS ACCUMULATED TO ONE HALF OF THE INS BE REPAIRED AND/OR REPLACED AS NECESSARY. ANY SEDIMENT INCORPORATED INTO THE EXISTING GRADE, SEEDED AND MULCHED.

5. REMOVAL OF SILT FENCE / TEMPORARY SEDIMENT CONTROL MEA

6. TO PROVIDE PROTECTION AGAINST EROSION, RIPRAP WILL BE PL EROSION AND SEDIMENTATION CONTROL BMP H-1, H-2.

7. ALL DITCH BASES TO BE SEEDED SHALL ALSO BE LINED WITH E DAMS AND TEMPORARY MULCHING WILL BE USED TO STABILIZE ANY NEXT SEVEN (7) DAYS.

8. NATIVE TOPSOIL SHALL BE SAVED, STOCKPILED, MULCHED, AND F WITHIN SEVEN (7) DAYS OF THE FORMATION OF THE STOCKPILE. 24 HOURS OF THE FORMATION OF THE STOCKPILE. UPHILL OF ST FROM THE PILES. SIDE SLOPES OF TOPSOIL STOCKPILES SHALL N

9. THE EXPOSED AREA SHOULD BE LIMITED TO THAT IN WHICH WO SEEDING AND REVEGETATION PLAN

UPON COMPLETION OF SITE CONSTRUCTION, ALL AREAS PREVIOUSLY CONTRACTOR UNTIL SUCH TIME AS A SATISFACTORY GROWTH OF VE

1. LOAM WILL BE SPREAD OVER ALL DISTURBED AREAS AND GRADE

2. ALL EXPOSED SURFACES NOT TO BE FINAL GRADED FOR THIRTY PERENNIAL, DEPENDING ON THE TIME OF YEAR. SEE MAINE EROSI

3. AGRICULTURAL LIMESTONE AND FERTILIZER WILL BE INCORPORAT

4. DISTURBED AREAS WILL BE SEEDED AT THE RATE OF 3 LB PER 5. SEEDING WILL BE COMPLETED BETWEEN THE DATES OF MAY 1 A

6. AREAS WHICH HAVE BEEN TEMPORARILY OR PERMANENTLY SEED

7. HAY MULCH WILL BE APPLIED AT THE RATE OF 75–90 LBS PER AND ON AREAS WITHIN 100 FEET OF LAKES, STREAMS, AND WETLA SEDIMENTATION CONTROL BMP D–1 AND THE CONTRACT SPECIFICAT 8. ALL MULCHES SHALL BE INSPECTED PERIODICALLY, PARTICULARLY

SPREAD. 9. ALL SEDIMENT CONTROL STRUCTURES WILL REMAIN IN PLACE UN VIGOROUS GROWTH.

FALL/WINTER SEEDING AND STABILIZATION

SEE MAINE EROSION AND SEDIMENTATION CONTROL BMP A-3 FOR

BY SEPTEMBER 1– 1. ALL GRASS–LINED DITCHES AND CHANNELS WILL BE CONSTRUCT SEPTEMBER 15, MULCH ANCHORING SHOULD BE USED ON SLOPES ON SLOPES GREATER THAN 12:1 AND ON SIDE SLOPES OF DITCHES

BY OCTOBER 1— 1. SOD WILL BE PLACED IN ALL DITCH CHANNELS WHERE VEGETATION ALL SLOPES GREATER THAN 7:1 WILL BE SEEDED TO A WINTER CO OR FAILS TO COVER AT LEAST 75% OF THE SLOPE BY NOVEMBER

BY NOVEMBER 1-1. THE DITCH WILL BE LINED WITH STONE RIPRAP. THE SLOPE WI BY NOVEMBER 15-

1. THE DISTURBED SOIL WILL BE MULCHED AT THE WINTER RATE A

THE WINTER CONSTRUCTION PERIOD IS FROM NOVEMBER 1 TO APP 1. WINTER EXCAVATION AND EARTHWORK SHALL BE COMPLETED SU

WILL BE LIMITED TO THAT IN WHICH WORK IS TO OCCUR DURING

2. HAY MULCH WILL BE APPLIED TO A DEPTH OF 4 INCHES (150 L 3. AFTER EACH DAY OF FINAL GRADING, ANY DISTURBED AREA WILL THROUGH THE MULCH.

4. SOIL STOCKPILES WILL BE MULCHED AT WINTER RATES WITHIN 2 WITHIN 100 FEET OF LAKES, STREAMS, WETLANDS, OR OTHER NATU

MONITORING PROGRAM SEDIMENTATION AND EROSION CONTROL STRUCTURES WILL BE INSE THE ELEMENTS WILL BE REPAIRED IMMEDIATELY. FOLLOWING RAIN

THE ELEMENTS WILL BE REPAIRED IMMEDIATELY. FOLLOWING RAINS DAMAGE. ALL DAMAGED STRUCTURES WILL BE REPAIRED AND/OR / FOLLOWING THE FINAL SEEDING THE SITE WILL BE INSPECTED TO E

INSPECTIONS, IN THE EVENT OF ANY UNSATISFACTORY GROWTH.

AFTER THE PROJECT AREA HAS STABILIZED, THE CONTRACTOR SHAL IMPLEMENTATION AND MONITORING OR EROSION CONTROL MEASURES THE INSPECTOR FOR AVIEST ENGINEERING.

HOUSEKEEPING AND INSPECTION THE CONTRACTOR IS TO REFER TO THE MAINE EROSION AND SEDIM DOCUMENTATION.

1117 EXISTING GROUND -----

EROSION

CONTROLLING SOIL EROSION AND SEDIMENTATION DURING AND AFTER CONSTRUCTION OF THE PROPOSED PROJECT. ROSION PREVENTION IN DEVELOPING AREAS AS CONTAINED IN THE 2016 ONLINE VERSION OF THE MAINE EROSION ENT OF ENVIRONMENTAL PROTECTION.	AVEST		
AY INCLUDE THE FOLLOWING: BACKHOE, BULLDOZER, LOADER, TRUCKS, COMPACTOR, AND GRADER. INTENSIVE OLLOWING METHODS WILL BE UNDERTAKEN TO PROVIDE MAXIMUM PROTECTION TO THE SOIL, WATER, AND ABUTTING	<b>ENGINEERING</b> 120 RABBIT RIDGE RD		
PES, CHANNELS, DITCHES, OR ANY DISTURBED LAND AREA WILL BE COMPLETED WITHIN SEVEN (7) CALENDAR DAYS POSSIBLE OR PRACTICAL TO PERMANENTLY STABILIZE DISTURBED LAND, TEMPORARY EROSION CONTROL MEASURES POSURE OF SOIL. TEMPORARY EROSION CONTROL MEASURES SHALL INCLUDE AT A MINIMUM THE APPLICATION OF Y THE WET APPLICATION METHOD AS OUTLINED IN THE CONTRACT SPECIFICATIONS. WITHIN 75 FEET OF WETLAND 48 HOURS, OR PRIOR TO ANY STORM EVENT, WHICHEVER IS FIRST.	WOODLAND, MAINE 04736 TEL: (207) 227-1057		
ENCE WILL BE INSTALLED ACROSS THE SLOPE ON THE CONTOUR AT THE DOWNHILL LIMIT OF THE WORK AS NCE SHALL ALSO BE INSTALLED AT THE DOWNHILL LIMIT OF THE BASE OF SOIL STOCKPILES.			
L EXISTING CULVERT/STORM DRAIN INLET LOCATIONS. SEE MAINE EROSION AND SEDIMENTATION CONTROL BMP C-2. WILL BE INSPECTED BY THE CONTRACTOR ON A WEEKLY BASIS, FOLLOWING ANY SIGNIFICANT RAINFALL (1/2 INCH OR	TE OF MANE		
ALL DAMAGED SILT FENCE WILL BE REPAIRED AND/OR REPLACED IMMEDIATELY. TRAPPED SEDIMENT WILL BE NSTALLED SILT FENCE HEIGHT. SILT FENCE NO LONGER SERVICEABLE DUE TO SEDIMENT ACCUMULATION WILL ALSO I DEPOSITS REMAINING IN PLACE AFTER THE SILT FENCE OR FILTER BARRIER IS NO LONGER REQUIRED SHOULD BE D.	SHARE M. MODULALL No. 12-99		
EASURES SHALL OCCUR WITHIN THIRTY (30) DAYS OF PERMANENT STABILIZATION. PLACED AT ALL STORM DRAIN INLETS AND OUTLETS AS SHOWN ON THE CONTRACT DRAWINGS. SEE ALSO MAINE			
EROSION CONTROL MESH TO STABILIZE THE DITCH CHANNELS UNTIL VEGETATION IS ESTABLISHED. STONE CHECK NY SECTION OF ROUGH GRADED DITCH THAT WILL NOT BE FINAL GRADED AND PERMANENTLY STABILIZED WITHIN THE	IPS SMM AS SMM AS SMM AS SMM AS SMM AS SMM AS SMM AS SMM		
REUSED AS MUCH AS POSSIBLE ON THE SITE. STOCKPILES WILL BE STABILIZED BY SEEDING AND MULCHING NEAR WETLAND AREAS (INCLUDING LAKES AND STREAMS), SEEDING AND MULCHING SHALL BE COMPLETED WITHIN STOCKPILES, STABILIZED DITCHES AND/OR BERMS WILL BE CONSTRUCTED TO DIVERT STORMWATER RUNOFF AWAY NOT EXCEED 2:1.	AS A		
ORK IS TO OCCUR DURING THE FOLLOWING 15 DAYS.	NTS NTS NTS NTS NTS		
SLY DISTURBED WILL BE TREATED AS STATED BELOW. THESE AREAS WILL BE CLOSELY MONITORED BY THE VEGETATION IS ESTABLISHED.	T COMMENTS T COMMENTS T COMMENTS T COMMENTS T COMMENTS T COMMENTS DN		
DED TO A UNIFORM DEPTH OF 4 INCHES. TY (30) DAYS OR MORE SHALL BE SEEDED WITH WINTER RYE, OATS, ANNUAL RYEGRASS, OR SUDANGRASS	ER CLIENT ER CLIENT ER CLIENT ER CLIENT ER CLIENT ER CLIENT ER CLIENT ER CLIENT ER CLIENT		
SION AND SEDIMENTATION CONTROL BMP A-3 FOR DETAILS AND SPECIFICATIONS.			
R 1000 SF. SEE THE CONTRACT SPECIFICATIONS FOR SEED MIX.	REVISIONS   REVISIONS   REVISIONS   REVISIONS   FOR		
AND SEPTEMBER 15. IRRIGATION MAY BE REQUIRED DURING THE PERIOD OF JUNE 1 TO AUGUST 15.	REVISIO		
ER 1000 SF. MULCH SHALL BE ANCHORED WITH BIODEGRADABLE NETTING ON STEEP SLOPES (7:1 OR GREATER) LANDS. EROSION CONTROL MIX CAN BE USED ON SLOPES BETWEEN 3:1 AND 2:1. SEE MAINE EROSION AND			
ATIONS.	21 22 23 23		
RLY AFTER RAINFALL. IF LESS THAN 90% OF THE DISTURBED AREA IS COVERED, ADDITIONAL MULCH WILL BE	- 200 - 200 - 200 - 200 - 200 - 200		
JNTIL VEGETATION IS ESTABLISHED. ESTABLISHED MEANS A MINIMUM OF 85% OF THE AREA IS VEGETATED WITH	11-30- 10-24- 01-19- 05-18- 05-05 03-05 DA		
R DETAILS ON THE FOLLOWING:			
CTED AND STABILIZED. ALL SLOPES GREATER THAN 7:1 TO BE VEGETATED WILL BE SEEDED AND MULCHED (PAST ES GREATER THAN 20:1, AND HEAVY GRADE MATS AND BIODEGRADABLE NETTING SHOULD BE USED IN CONJUNCTION HES). IF THIS IS NOT COMPLETED, THEN:	AUBURN SOLAR LLC		
TION HAS NOT BEEN ESTABLISHED. SOD WILL EXTEND TO A HEIGHT OF ONE FOOT ABOVE DITCH CHANNEL BOTTOM. COVER CROP OF RYE AT A RATE OF 3 LBS PER 1000 SF. IF THE RYE FAILS TO GROW AT LEAST THREE INCHES R 1, OR IF SOD IS NOT PLACED IN THE APPROPRIATE DITCH CHANNELS, THEN:	722 PRESTON AVE SUITE 102 CHARLOTTESVILLE, VA		
WILL BE COVERED WITH EROSION CONTROL MIX OR STONE RIPRAP, OR, ALTERNATIVELY:	22903		
AND ANCHORED PROPERLY.			
UCH THAT NO MORE THAN 1 ACRE OF THE SITE IS WITHOUT STABILIZATION AT ANY ONE TIME. THE EXPOSED AREA THE FOLLOWING 15 DAYS AND THOSE AREAS THAT CAN BE MULCHED IN ONE DAY PRIOR TO ANY SNOW EVENT.			
) LBS PER 1000 SF). LL BE STABILIZED WITH ANCHORED MULCH OR EROSION CONTROL MESH. NO GROUND SURFACE SHOULD BE VISIBLE	AUBURN 0.99MW SOLAR ARRAY		
24 HOURS OF STOCKING AND REESTABLISHED PRIOR TO RAIN OR SNOWFALL. NO STOCKPILES WILL BE PLACED	NORTH RIVER ROAD		
TURAL RESOURCES.	AUBURN, MAINE		
SPECTED WEEKLY BY THE CONTRACTOR, AND ALL STRUCTURES DAMAGED BY CONSTRUCTION EQUIPMENT, VANDALS, OR NSTORMS AND DURING RUNOFF EVENTS, THE SITE AND ALL STRUCTURES WILL BE INSPECTED FOR EROSION AND			
ADDITIONAL EROSION CONTROL STRUCTURES WILL BE INSTALLED PRIOR TO CONTINUING THE CONSTRUCTION. ENSURE THAT THE VEGETATION HAS BEEN ESTABLISHED. RESEEDING WILL BE CARRIED OUT, WITH FOLLOW-UP	SHEET TITLE STORMWATER		
IALL REMOVE ALL SILT FENCE AND ANY OTHER TEMPORARY EROSION CONTROL MEASURES.	MANAGEMENT		
RES WILL BE THE RESPONSIBILITY OF THE CONTRACTOR UNDER THE SUPERVISION OF THE PROJECT ENGINEER AND	& EROSION CONTROL		
	PLAN AND DETAILS		
DIMENT CONTROL BEST MANAGEMENT PRACTICES (BMP) MANUAL OCTOBER 2016 FOR GUIDELINES AND	DRAWN BY DATE TPS NOV. 2023		
	CHECKED BY A E PROJECT #		
	PROJ. ENG. A E ARCHIVE #		
RUNOFF FILL SLOPE	SMM SHEET NUMBER		
4'			
CONTROL MIV REDM RETAIL	C2		
CONTROL MIX BERM DETAIL scale: nts	SHEET 2 OF 2		